




FOUNDATION PLAN
SCALE: 1/4" = 1'-0"
TRUE NORTH
PROJECT NORTH

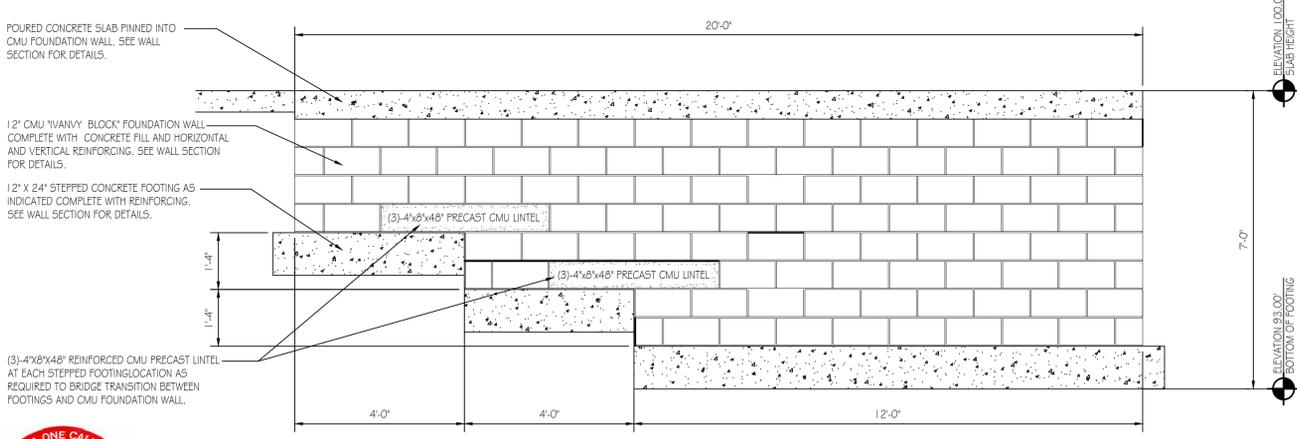


FOUNDATION ELEVATION PROFILE 'A'
SCALE: 1/2" = 1'-0"

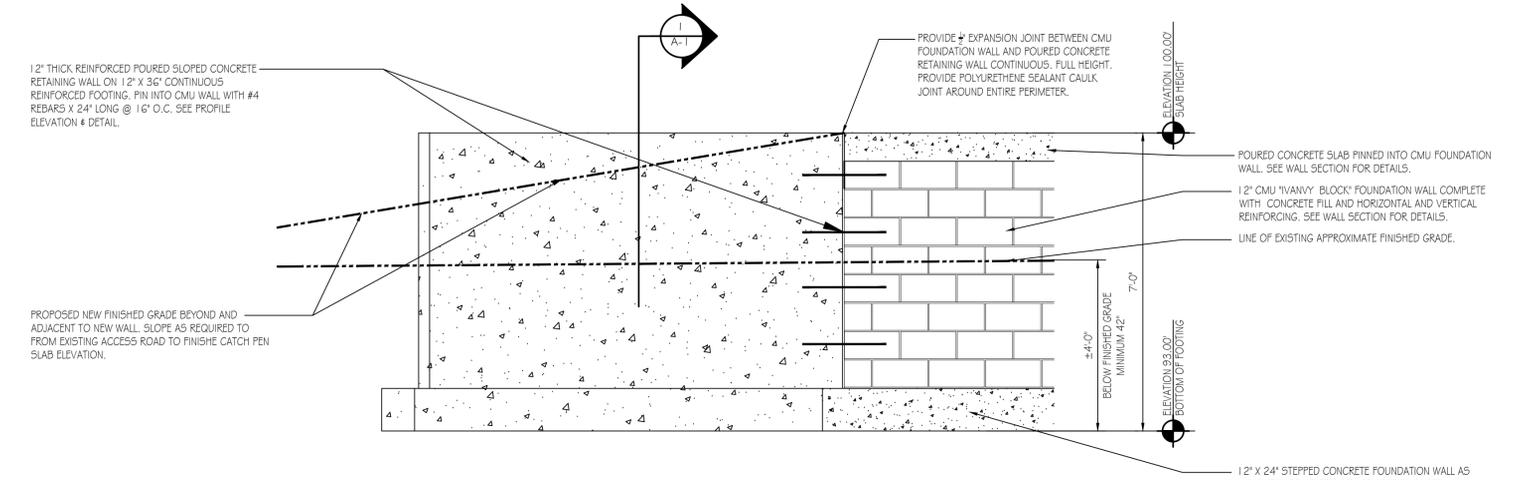

FOUNDATION ELEVATION PROFILE 'B'
SCALE: 1/2" = 1'-0"

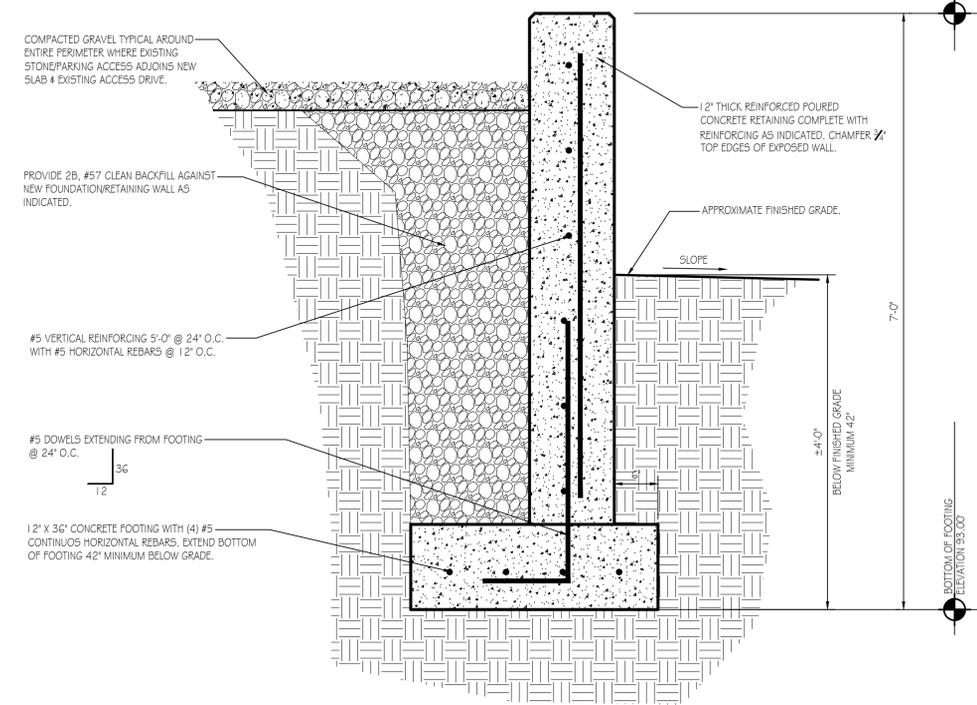

WALL SECTION DETAIL
SCALE: 1" = 1'-0"

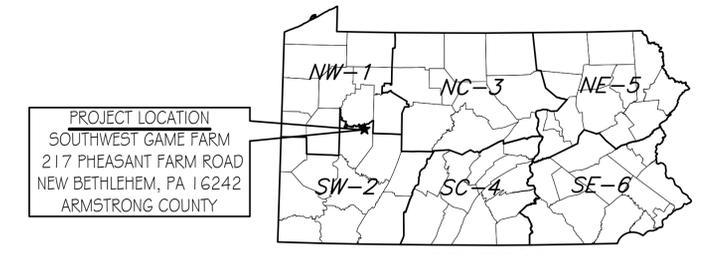

PROJECT MAP
NOT TO SCALE



PROJECT VICINITY MAP
NOT TO SCALE

BUILDING CODE SUMMARY

Code: International Building Code, 2018 edition

Scope: Construction of a new catch pen structure is for the Southwest Game Farm located in Mahoning Township, Armstrong County. The new structure is open on (3) sides and is strictly used for agricultural purposes in catching and transporting pheasants for the propagation program being run by the Pennsylvania Game Commission.

Summary:
Use & Occupancy Group: 312.1 Agricultural Building/Utility and Miscellaneous Group U

Construction Type: VB (Table 601)

New Building Area: 1,296 s.f.

Allowable Area: 12,000 s.f. (C102.1)

Building Stories: 1 Story, No basement, Allowable Stories: 2 (C102.1)

Fire Protection: No fire suppression, not required.

Fire Extinguishers: No Required [F] 90G.1

Occupant Load: Agricultural, Occupancy Factor = 300 gross
1,296 S.F./300 = 4.3 ~ 5 persons

Egress Width: N/A open sided structure

Means Of Egress: N/A open sided structure

Accessibility: Not required, agricultural building. (Chapter 11)

Energy Efficiency: Building/structure will not be heated or airconditioned. Low-Energy Building (IECC) (C402.1.1)

PENNSYLVANIA GAME COMMISSION		
SOUTHWEST GAME FARM MAHONING TOWNSHIP ARMSTRONG COUNTY		
NEW CATCH PEN STRUCTURE		
FOUNDATION PLAN & DETAILS		
REVISIONS	PROJECT NO.	PGC-SWGF-02-23
	DRAWN BY:	M. SPOTTIS
	DATE:	1/10/2023
	SHEET NO.	A-1



EXTERIOR BREAKER BOX LOAD CENTER - 40A
VOLTAGE: 120/240V
ELECTRICAL FEEDER SIZE FROM EXISTING PANEL: 8AWG

CIRCUIT NO.	CIRCUIT BREAKERS		EXISTING 400 AMP PANEL AND FEED FROM DOUBLE POLE 40AMP BREAKER	Wire	
	POLES	AMPS		No.	Size
1	1	20	CATCH PEN RECEPTACLES	3 - #12	3/4"
2	1	20	CATCH PEN LIGHTING	3 - #12	3/4"

ELECTRICAL WIRING SYMBOLS

- GFI-WATER RESISTANT-RECEPTACLE
- GFI RECEPTACLE
- DUPLEX OUTLET, SPLIT CIRCUIT
- DUPLEX OUTLET
- 50 AMP, 220 VOLT OUTLET, WELDER (VERIFY TYPE & LOCATION WITH FGC)
- 30 AMP, 220 VOLT OUTLET
- 30 AMP, 220 VOLT OUTLET (DRYER)
- HOME RUN/CIRCUIT #
- TELECOMMUNICATIONS OUTLET
- JUNCTION BOX
- PHOTO CELL
- EXIT LIGHTING W/BATTERIES
- SWITCH
- 3 SWITCH, 3 WAY
- 4 SWITCH, 4 WAY
- OCC SWITCH, OCCUPANCY SENSOR
- PRESSURE SWITCH
- WATER PUMP


GENERAL ELECTRICAL NOTES:

- FURNISH AND INSTALL SOLID COPPER CONDUCTORS AS SPECIFIED; NO ALUMINUM AND NO STRANDED. MC CABLE IS APPROVED FOR ALL HOME RUN CIRCUITS IF NEATLY INSTALLED.
- ALL CONDUCTORS FOR 120V CIRCUITS OVER 100' IN LENGTH SHALL BE MINIMUM #10AWG. ALL CONDUCTORS FOR 120V CIRCUITS OVER 150' IN LENGTH SHALL BE MINIMUM #8AWG. CONTRACTOR IS RESPONSIBLE FOR VERIFICATION OF FINAL CIRCUIT LENGTHS AND CORRESPONDING WIRE SIZE TO ENSURE VOLTAGE DROP IS MAINTAINED WITHIN NEC LIMITS.
- ALL WORK SHALL BE PERFORMED AS REQUIRED BY APPLICABLE SECTION OF THE NATIONAL ELECTRICAL CODE (NEC), LATEST EDITION, AND ALL GOVERNING UCC BUILDING CODES AND REGULATIONS.
- PROVIDE GROUNDING AND BONDING FOR ELECTRICAL SYSTEMS. ELECTRICAL COMPONENTS, DEVICES AND ACCESSORIES SHALL BE LISTED AND LABELED AS DEFINED IN NFPA 70 AND COMPLY WITH UL 467 FOR GROUNDING AND BONDING MATERIALS AND EQUIPMENT. INSTALL INSULATED EQUIPMENT GROUNDING CONDUCTORS ALL FEEDERS AND BRANCH CIRCUITS, LIGHTING CIRCUITS, RECEPTACLE CIRCUITS SINGLE PHASE MOTOR AND APPLIANCE BRANCH CIRCUITS, ARMORED AND METAL-CLAD CABLE RUNS AND AS REQUIRED BY NFPA 70.
- PROVIDE ALL HANGERS AND SUPPORTS FOR ELECTRICAL SYSTEMS, INCLUDING STEEL SLOTTED SUPPORT SYSTEMS, CONDUIT AND CABLE SUPPORT DEVICES, SUPPORTS FOR CONDUCTORS IN VERTICAL CONDUIT. HANGERS AND SUPPORTS SHALL HAVE A FLAME RATING OF CLASS 1 AND BE SELF-EXTINGUISHING ACCORDING TO ASTM D 635.
- ALL ELECTRICAL WIRE RUNS BELOW THE TRUSS UNMETAL CEILING EXTENDING VERTICAL AND HORIZONTAL ARE TO BE INSTALLED IN EMT CONDUIT OR SCHEDULE 40 PVC CONDUIT. DIAMETER TO CORRESPOND WITH WIRING SIZE. ALL REMAINING ELECTRICAL WIRE RUNS ABOVE CEILING AND ATTACHED TO THE TRUSS TO BE EXPOSED MC CABLE.

LIGHTING FIXTURE SCHEDULE

MARK	QTY	LIGHTING FIXTURE	MODEL
A	6	LED SURFACE MOUNTED CANOPY	PLT SOLUTIONS PLT-12487

- LIGHTING FIXTURE SCHEDULE NOTES:**
- RECEPTACLES AND SWITCH MOUNTING HEIGHTS - 48" A.F.F.

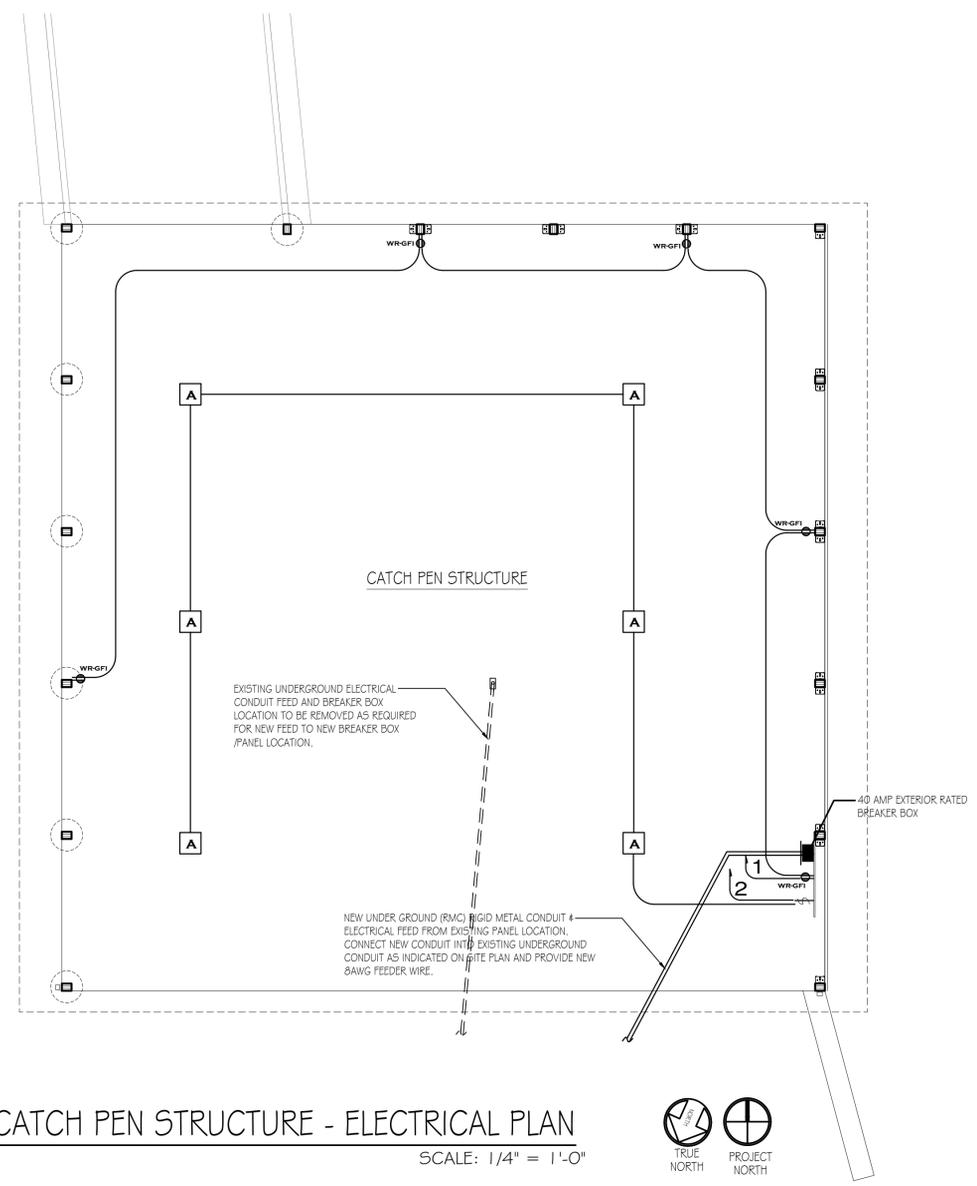

NEW CATCH PEN STRUCTURE - ELECTRICAL PLAN
SCALE: 1/4" = 1'-0"



PENNSYLVANIA GAME COMMISSION

SOUTHWEST GAME FARM | MAHONING TOWNSHIP | ARMSTRONG COUNTY

NEW CATCH PEN STRUCTURE

ELECTRICAL FLOOR PLAN, SCHEDULES & DETAILS

REVISIONS	PROJECT NO.	PGC-SWGF-02-23
	DRAWN BY:	M. SPOTTS
	DATE:	1/10/2023
	SHEET NO.	E-1