## PENNSYLVANIA GAME COMMISSION PROJECT NO. PGC-SWGF-02-23 SOUTHWEST GAME FARM NEW 36'X 36' CATCH PEN STRUCTURE


MAHONING TOWNSHIP, ARMSTRONG COUNTY, PENNSYLVANIA

CONTRACT NO. 1: GENERAL CONSTRUCTION


## SITE PLAN GENERAL NOTES:

- TEMPORARY POLE SUPPORT IS REQUIRED. THIS WORK SHALL BE COMPLETED AT NO ADDITIONAL COST TO THE OWNER.
- EXISTING DRAINAGE FACILITIES SHALL REMAIN INTACT DURING CONSTRUCTION. UNLESS OTHERWISE
- ALL AREAS DISTURBED BY THE CONSTRUCTION WORK SHALL BE RESTORED IN ACCORDANCE WITH THE CONTRACT DOCUMENTS TO THEIR ORIGINAL CONDITION OR BETTER.
- 6. ALL DISTURBED AREAS NOT RECEIVING OTHER SURFACE TREATMENT SHALL BE GRADED, SEEDED, AND
- 7. CONTRACTOR SHALL REFER TO CONTRACT DOCUMENTS FOR SOIL EROSION \$ SEDIMENTATION CONTROL PLAN REQUIREMENTS.
- 8. MAINTAIN ACCESS TO DRIVEWAYS AND ENTRANCES LOCATED ALONG THE PROJECT.
- 9. THE CONTRACTOR SHALL ENSURE THAT ALL CONSTRUCTION VEHICLES (INCLUDING MATERIAL SUPPLIER VEHICLES) LEAVING THE PROJECT AREA HAVE MUD BUILDUP REMOVED FROM THE TIRES BEFORE EXITING ONTO PAVED ROADWAYS. ALL MUD TRACKED ONTO PAVED ROADWAYS SHALL BE IMMEDIATELY REMOVED FROM THE ROADWAY.



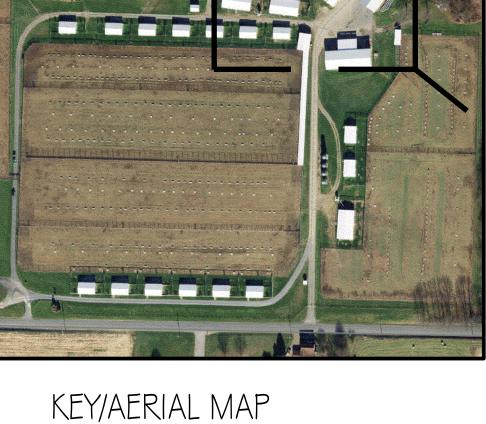




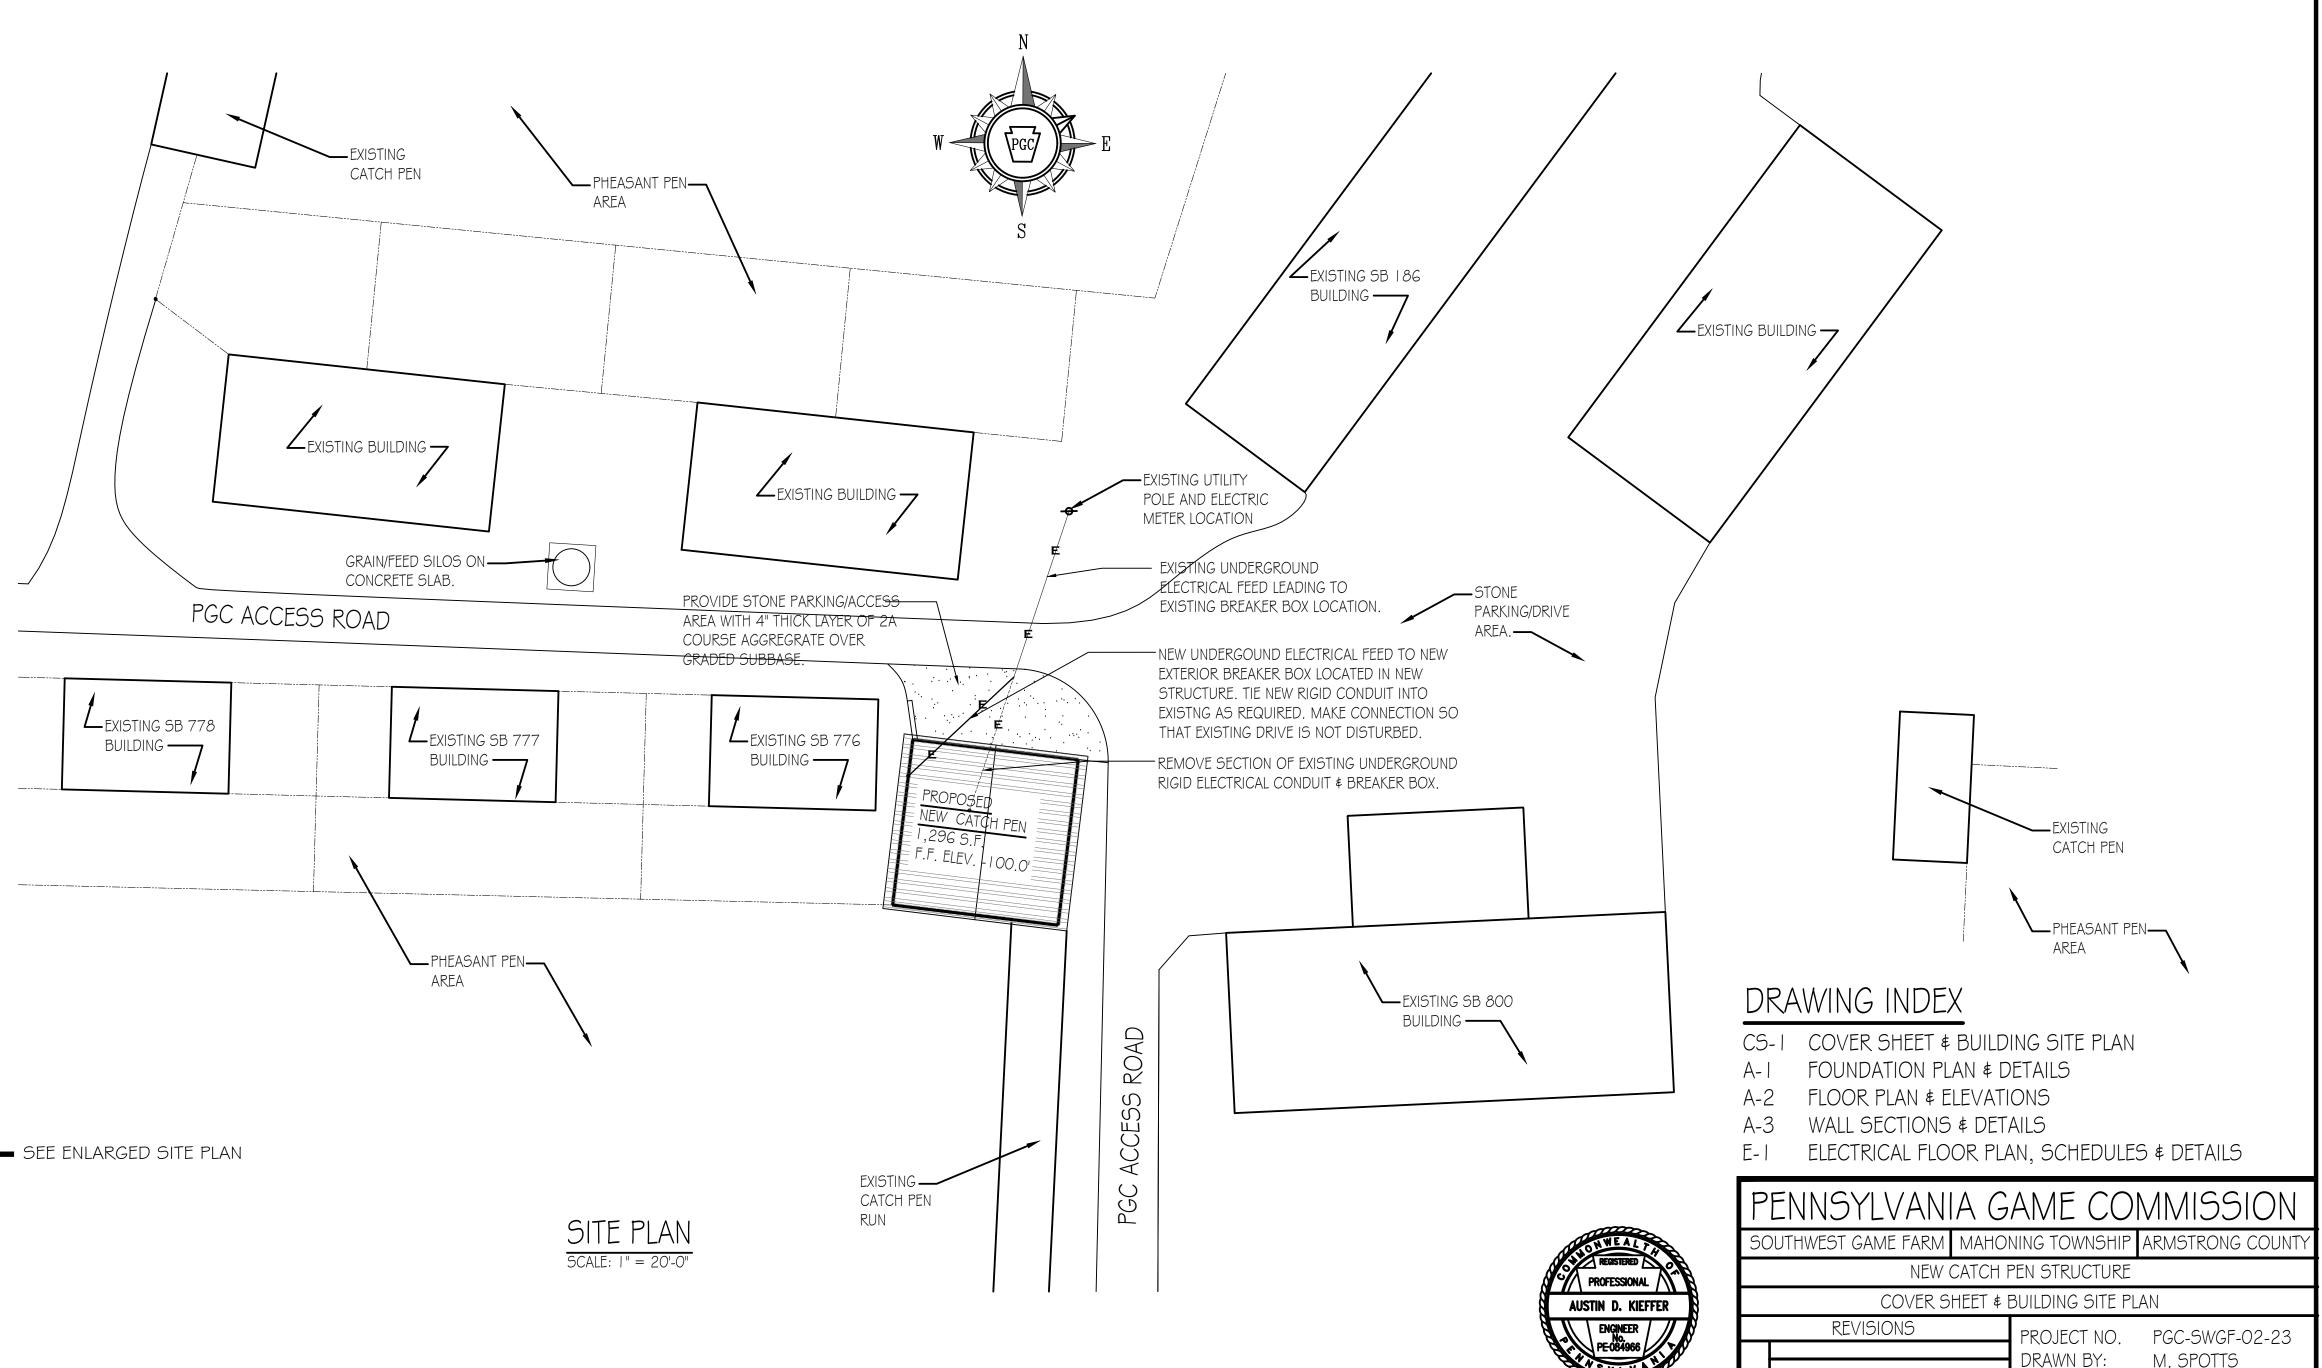



1/10/2023

CS-1

SHEET NO.

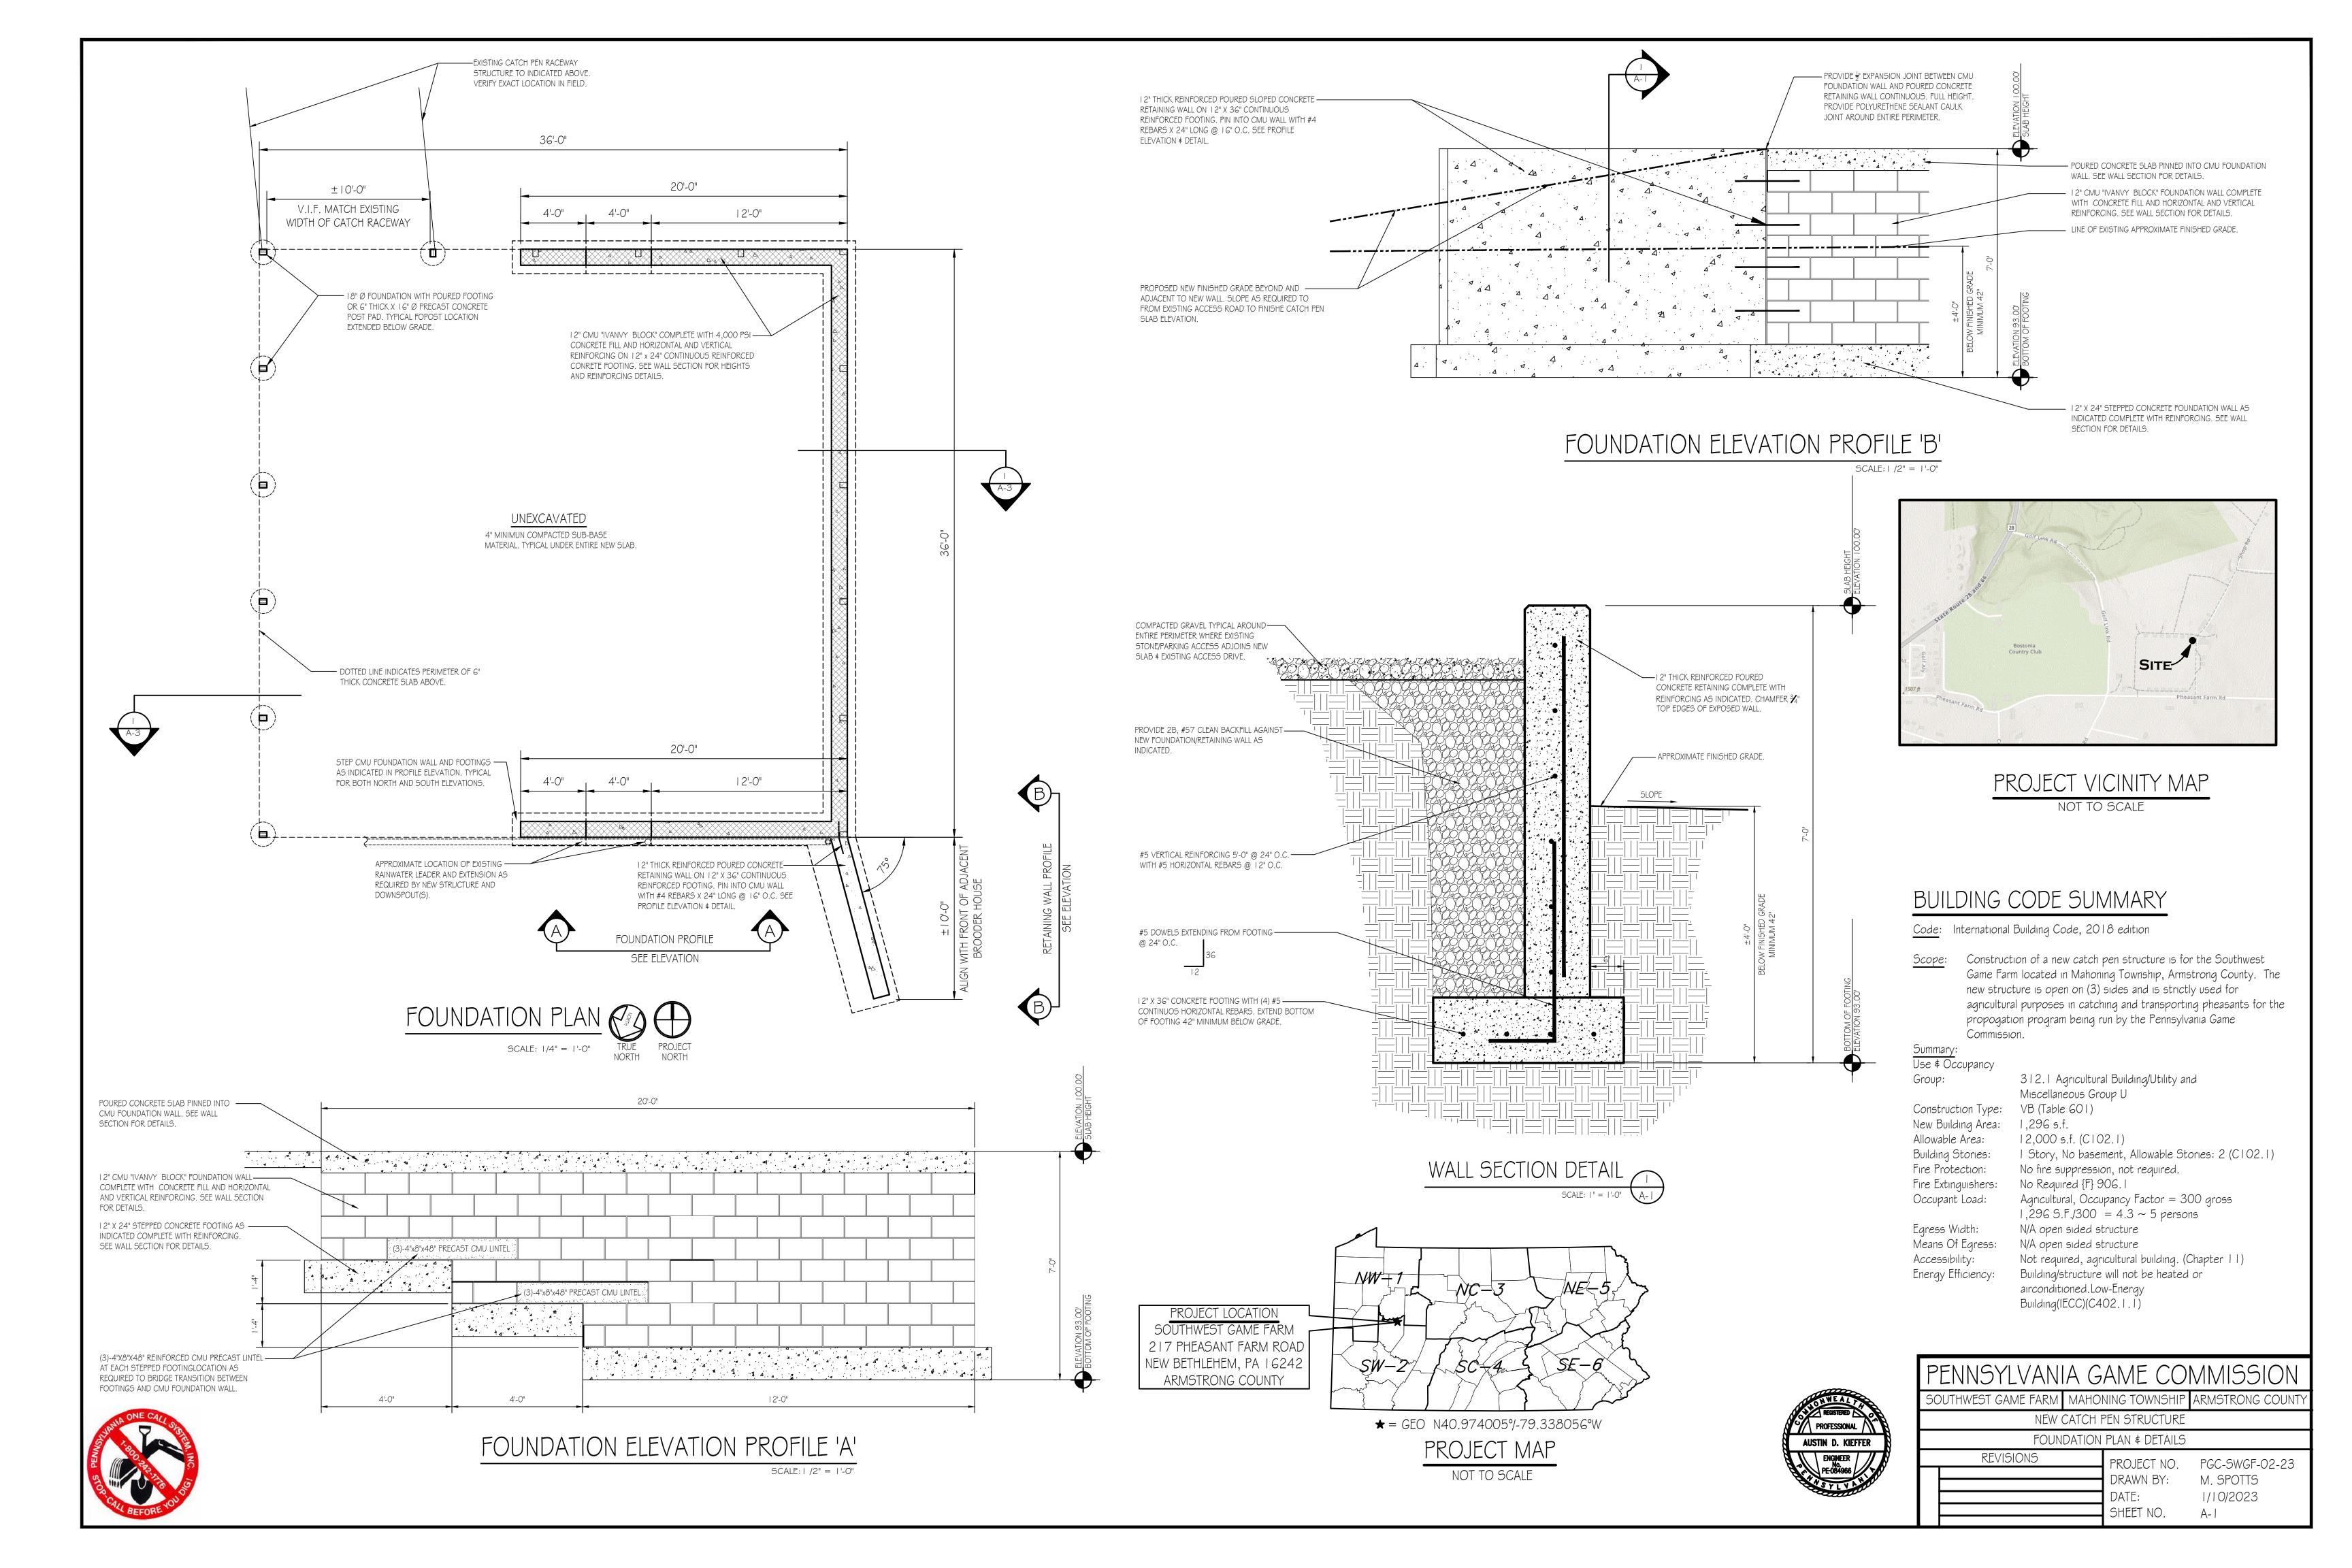

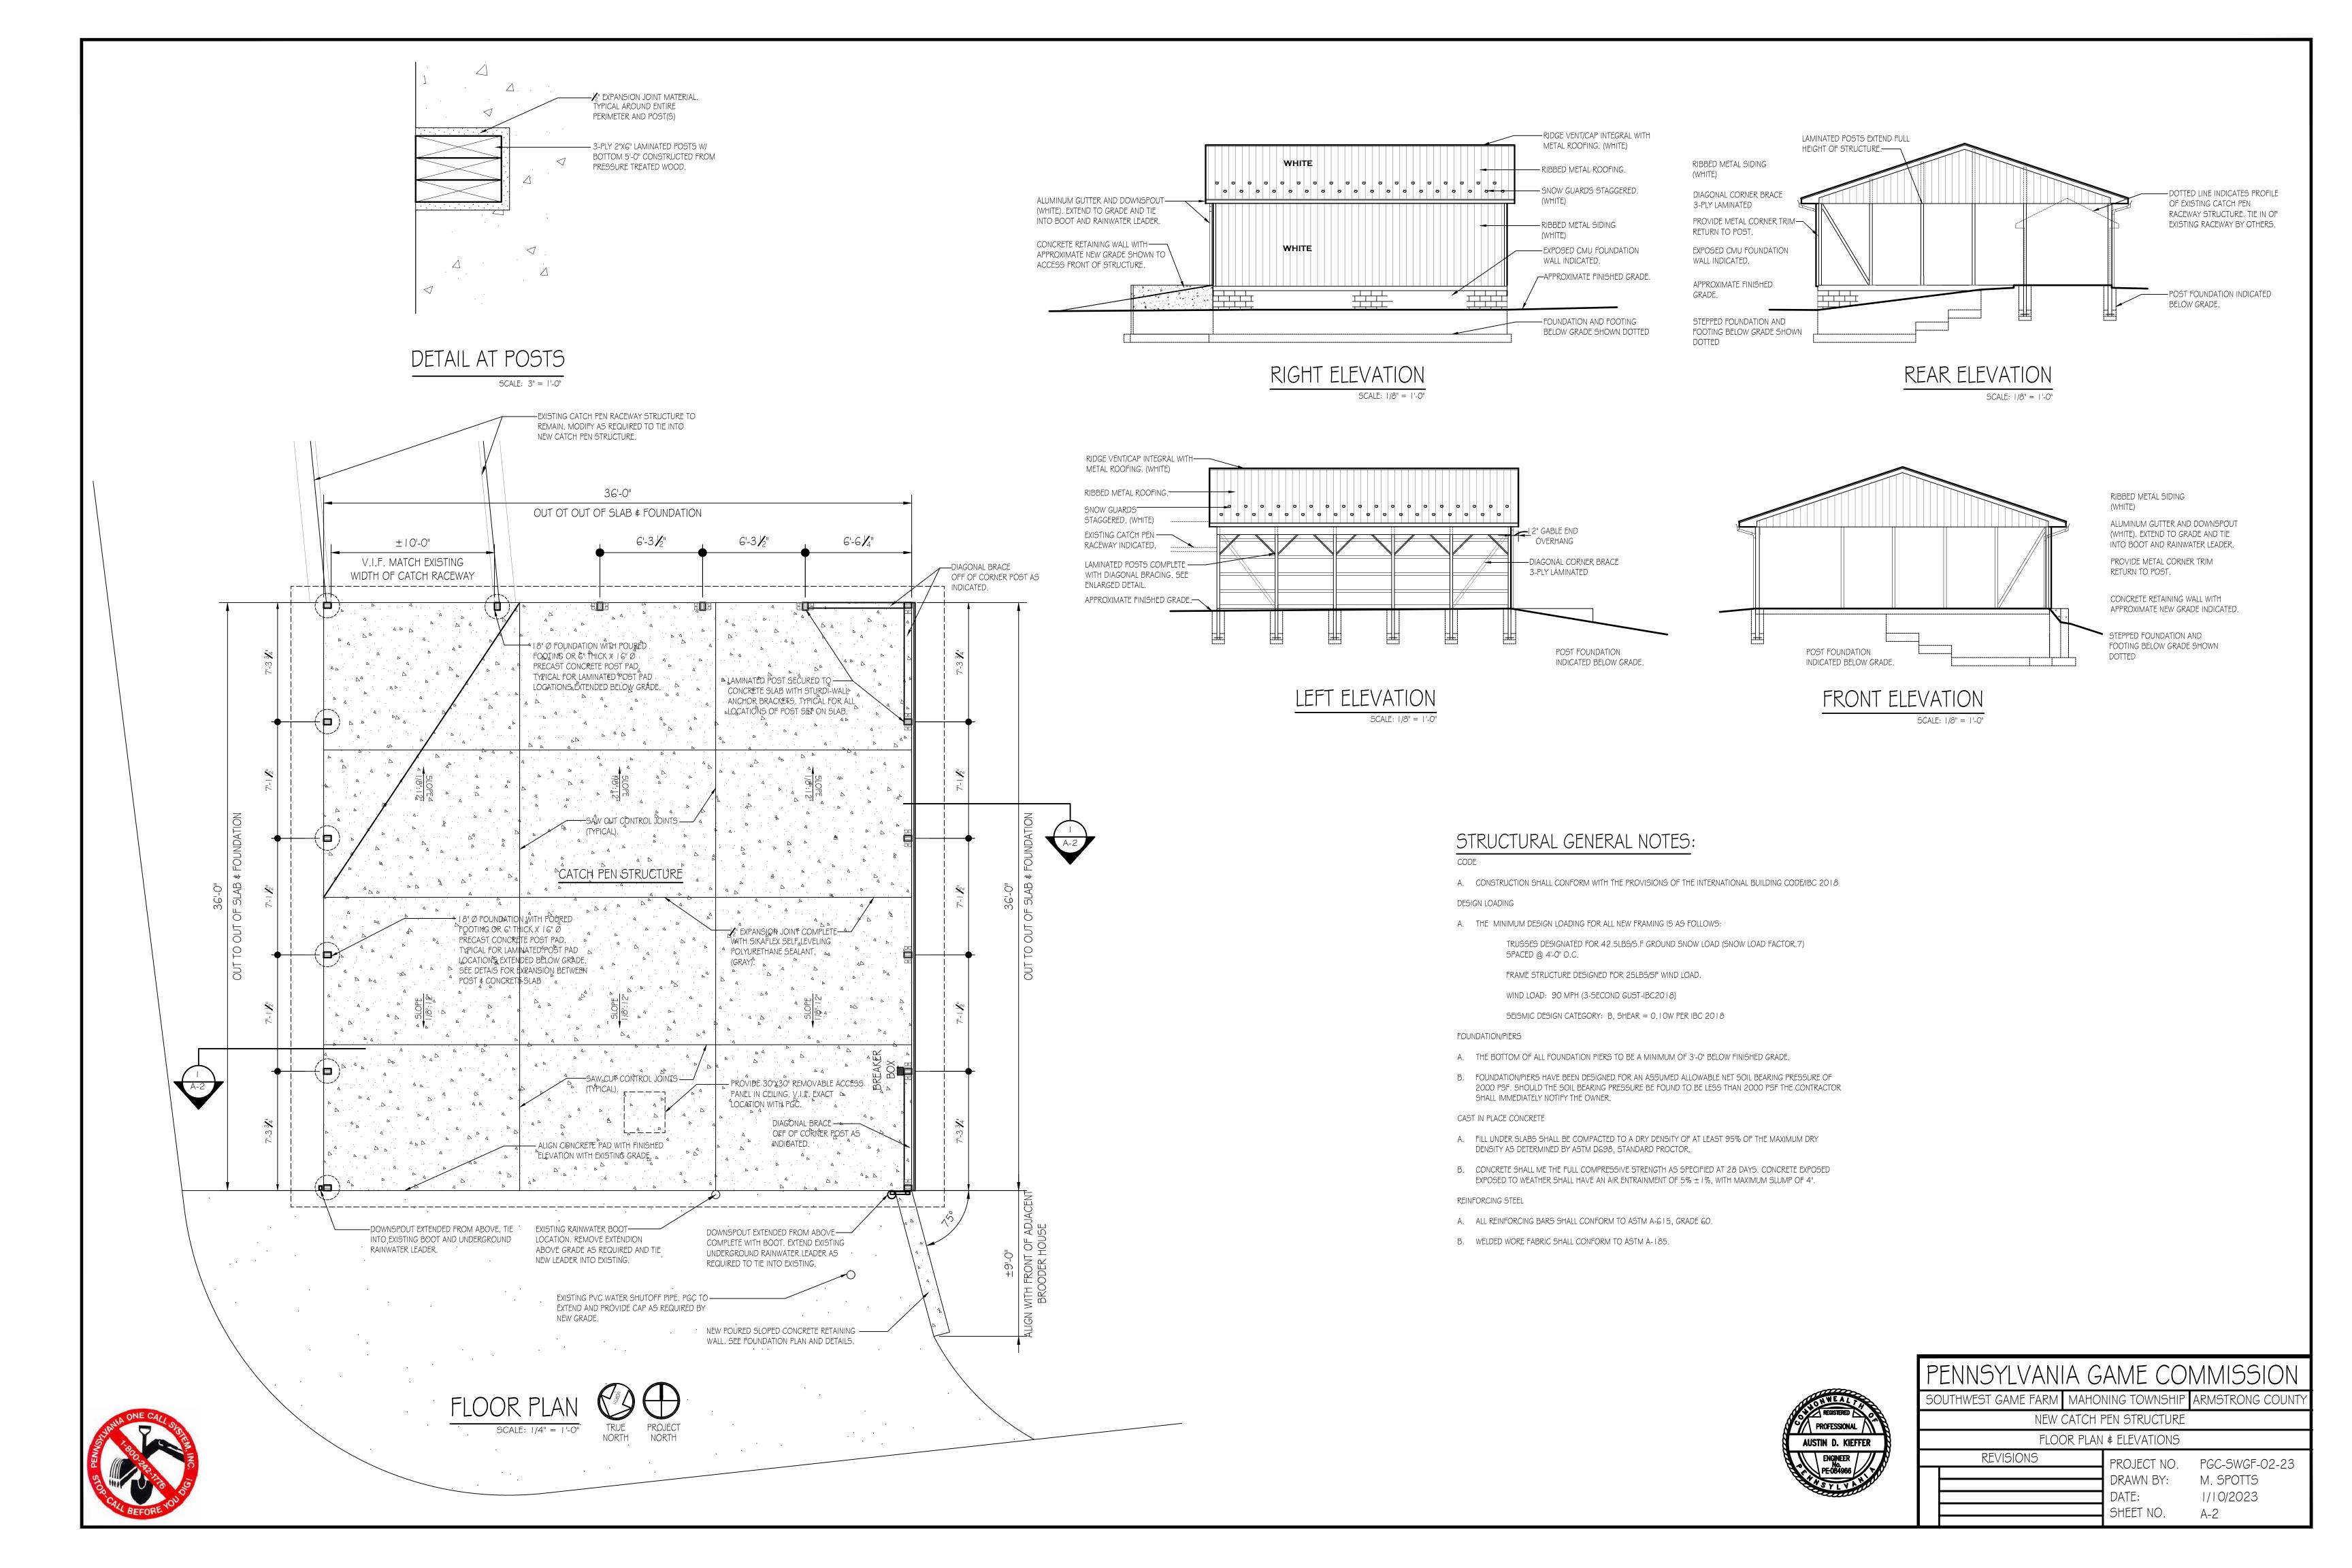

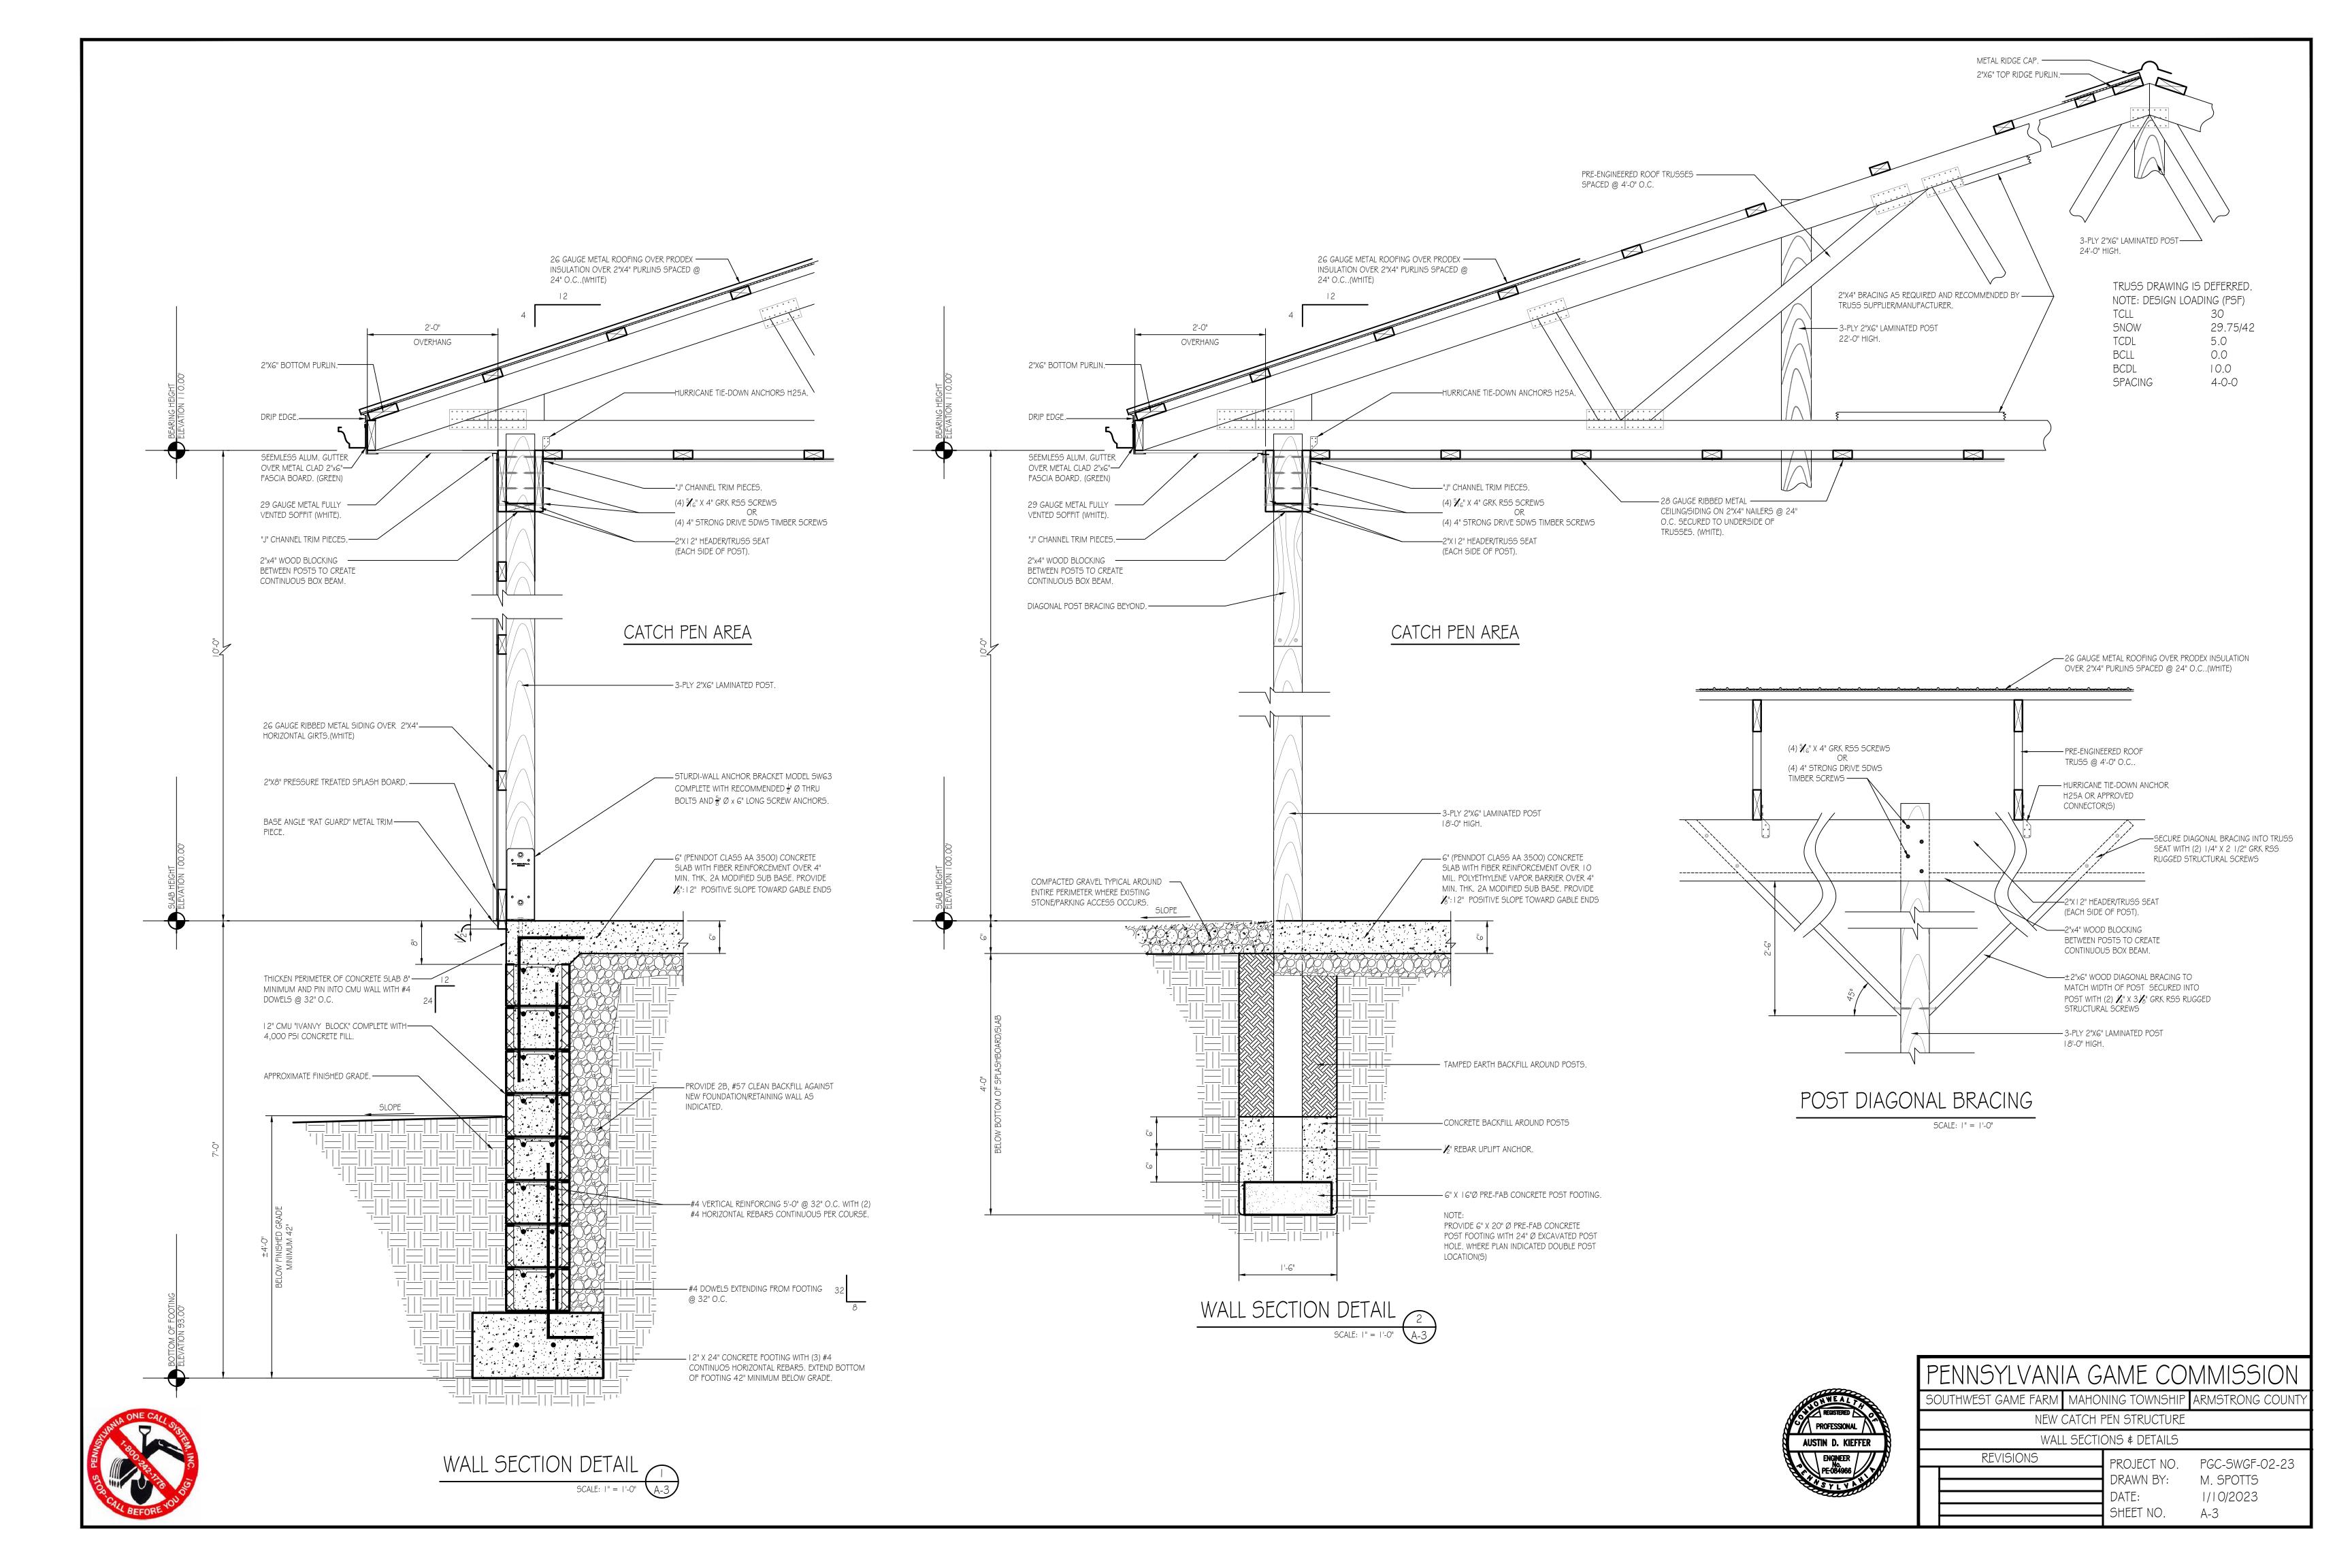

EXTERIOR BREAKER BOX LOAD CENTER - 40A VOLTAGE: 120/240V FLECTRICAL FEEDER SIZE FROM EXISTING PANEL: 8AWG

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CIRCUIT NO.	CIRCUIT BREAKERS		EXISTING 400 AMP PANEL AND FEED	Wiring	Conduit		
	POLES	AMPS	FROM DOUBLE POLE 40AMP BREAKER	No./Sıze	Sıze		
	- 1	20	CATCH PEN RECEPTACLES	3 - #12	3/4"		
2		20	CATCH PENN LIGHTING	3 - #12	3/4"		

## ELECTRICAL WIRING SYMBOLS

**WR-GFI GFI-WATER RESISTANT-RECEPTACLE** 

GFI GFI RECEPTACLE

➡ DUPLEX OUTLET, SPLIT CIRCUIT DUPLEX OUTLET

50 AMP, 220 VOLT OUTLET, WELDER (VERIFY TYPE \$ LOCATION WITH PGC)

30 AMP, 220 VOLT OUTLET

30 AMP, 220 VOLT OUTLET (DRYER)

→ HOME RUN/CIRCUIT #

➤ TELECOMMUNICATIONS OUTLET

JUNCTION BOX

PHOTO CELL

▶□ EXIT LIGHTING W/BATTERIES

SWITCH

\$3 SWITCH, 3 WAY

\$4 SWITCH, 4 WAY

\$00 SWITCH, OCCUPANCY SENSOR

PS PRESSURE SWITCH WATER PUMP

## GENERAL ELECTRICAL NOTES:


- FURNISH AND INSTALL SOLID COPPER CONDUCTORS AS SPECIFIED; NO ALUMINUM AND NO STRANDED. MC CABLE IS APPROVED FOR ALL HOME RUN CIRCUITS IF NEATLY INSTALLED.
- 2. ALL CONDUCTORS FOR 120V CIRCUITS OVER 100' IN LENGTH SHALL BE MINIMUM #10AWG. ALL CONDUCTORS FOR 120V CIRCUITS OVER 150' IN LENGTH SHALL BE MINIMUM #8AWG. CONTRACTOR IS RESPONSIBLE FOR VERIFICATION OF FINAL CIRCUIT LENGTHS AND CORRESPONDING WIRE SIZE TO ENSURE VOLTAGE DROP IS MAINTAINED WITHIN NEC LIMITS.
- 3. ALL WORK SHALL BE PERFORMED AS REQUIRED BY APPLICABLE SECTION OF THE NATIONAL ELECTRICAL CODE (NEC), LATEST EDITION, AND ALL GOVERNING UCC
- 4. PROVIDE GROUNDING AND BONDING FOR ELECTRICAL SYSTEMS. ELECTRICAL COMPONENTS, DEVICES AND ACCESSORIES SHALL BE LISTED AND LABELED AS DEFINED IN NFPA 70 AND COMPLY WITH UL 467 FOR GROUNDING AND BONDING MATERIALS AND EQUIPMENT. INSTALL INSULATED EQUIPMENT GROUNDING CONDUCTORS ALL FEEDERS AND BRANCH CIRCUITS, LIGHTING CIRCUITS, RECEPTACLE CIRCUITS SINGLE PHASE MOTOR AND APPLIANCE BRANCH CIRCUITS, ARMORED AND METAL-CLAD CABLE RUNS AND AS REQUIRED BY NFPA 70.
- 5. PROVIDE ALL HANGERS AND SUPPORTS FOR ELECTRICAL SYSTEMS, INCLUDING STEEL SLOTTED SUPPORT SYSTEMS, CONDUIT AND CABLE SUPPORT DEVICES, SUPPORTS FOR CONDUCTORS IN VERTICAL CONDUIT. HANGERS AND SUPPORTS SHALL HAVE A FLAME RATING OF CLASS I AND BE SELF-EXTINGUISHING
- ALL ELECTRICAL WIRE RUNS BELOW THE TRUSS LINE/METAL CEILING EXTENDING VERTICAL AND HORITONAL ARE TO BE INSTALLED IN EMT CONUIT OR SCHEDULE 40 PVC CONDUIT. DIAMETER TO CORRESPOND WITH WIRING SIZE. ALL REMAINING ELECTRICAL WIRE RUNS ABOVE CEILING AND ATTACHED TO THE TRUSS TO BE

LIGHTING	FIXTURF	SCHEDULE

EIGHTING TIXTURE GOTTEBULE						
MARK	QTY	LIGHTING FIXTURE	MODEL			
Α	6	LED SURFACE MOUNTED CANOPY	PLT SOLUTIONS PLT-12487			

LIGHTING FIXTURE SCHEDULE NOTES:

I. RECEPTACLES AND SWITCH MOUNTING HEIGHTS - 48" A.F.F.

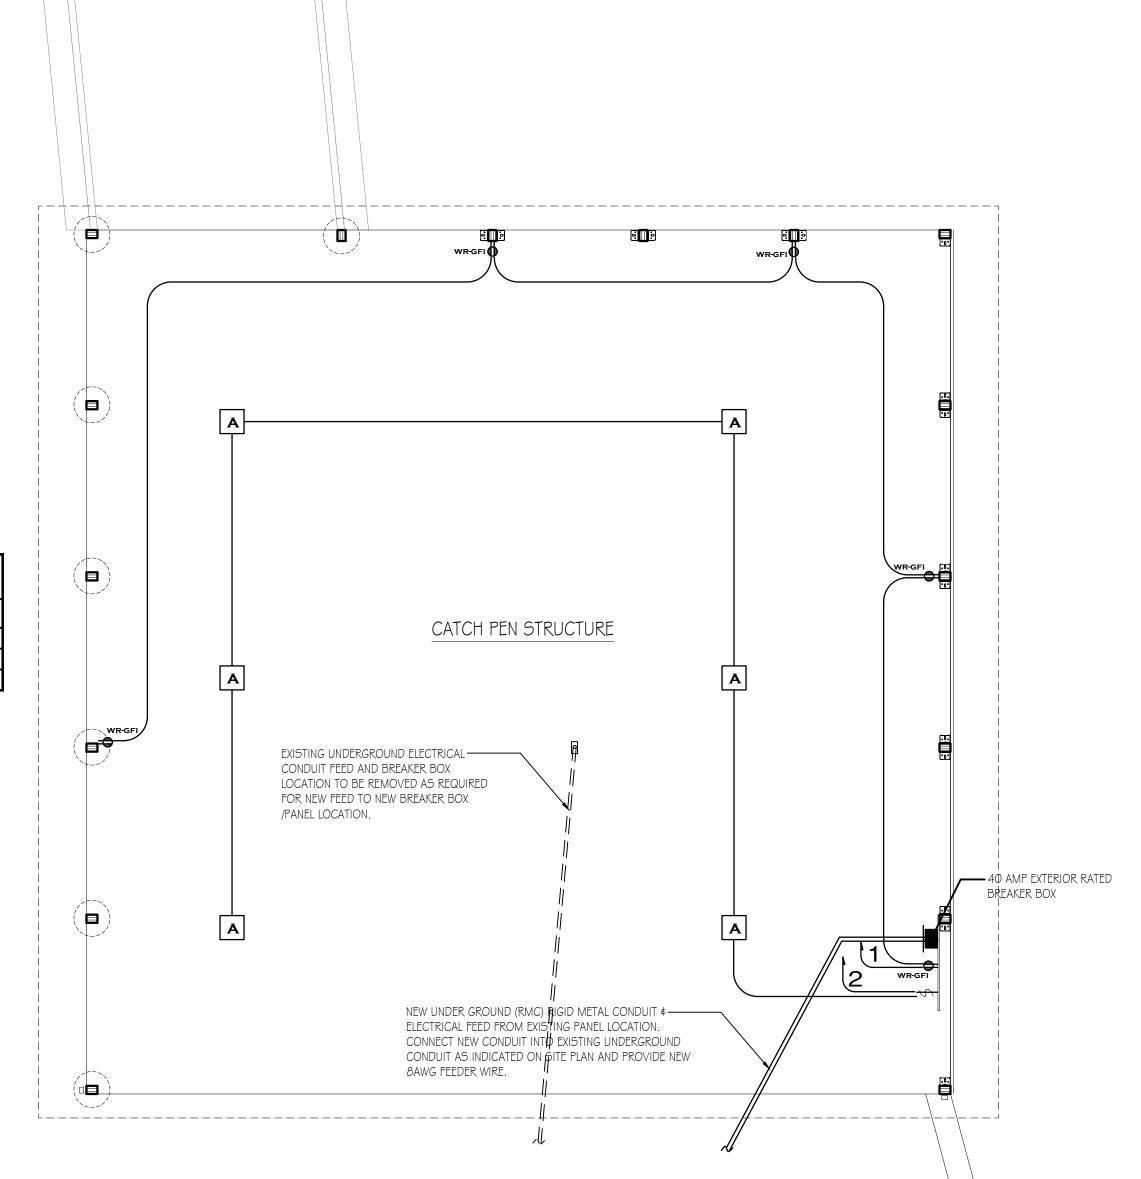

SCALE: 1/4" = 1'-0"

NEW CATCH PEN STRUCTURE - ELECTRICAL PLAN







PENNSYLVANIA GAME COMMISSION

SOUTHWEST GAME FARM MAHONING TOWNSHIP ARMSTRONG COUNT

NEW CATCH PEN STRUCTURE ELECTRICAL FLOOR PLAN, SCHEDULES & DETAILS REVISIONS

PROJECT NO. PGC-SWGF-02-23 DRAWN BY:

M. SPOTTS

1/10/2023

SHEET NO.